


NO.	DESCRIPTION	DATE
1	FINAL SCHEME	02.01.19
2	REV. FINAL SCHEME	02.07.19
3	CD REVIEW	04.15.19

MEZZ. FRAMING PLAN

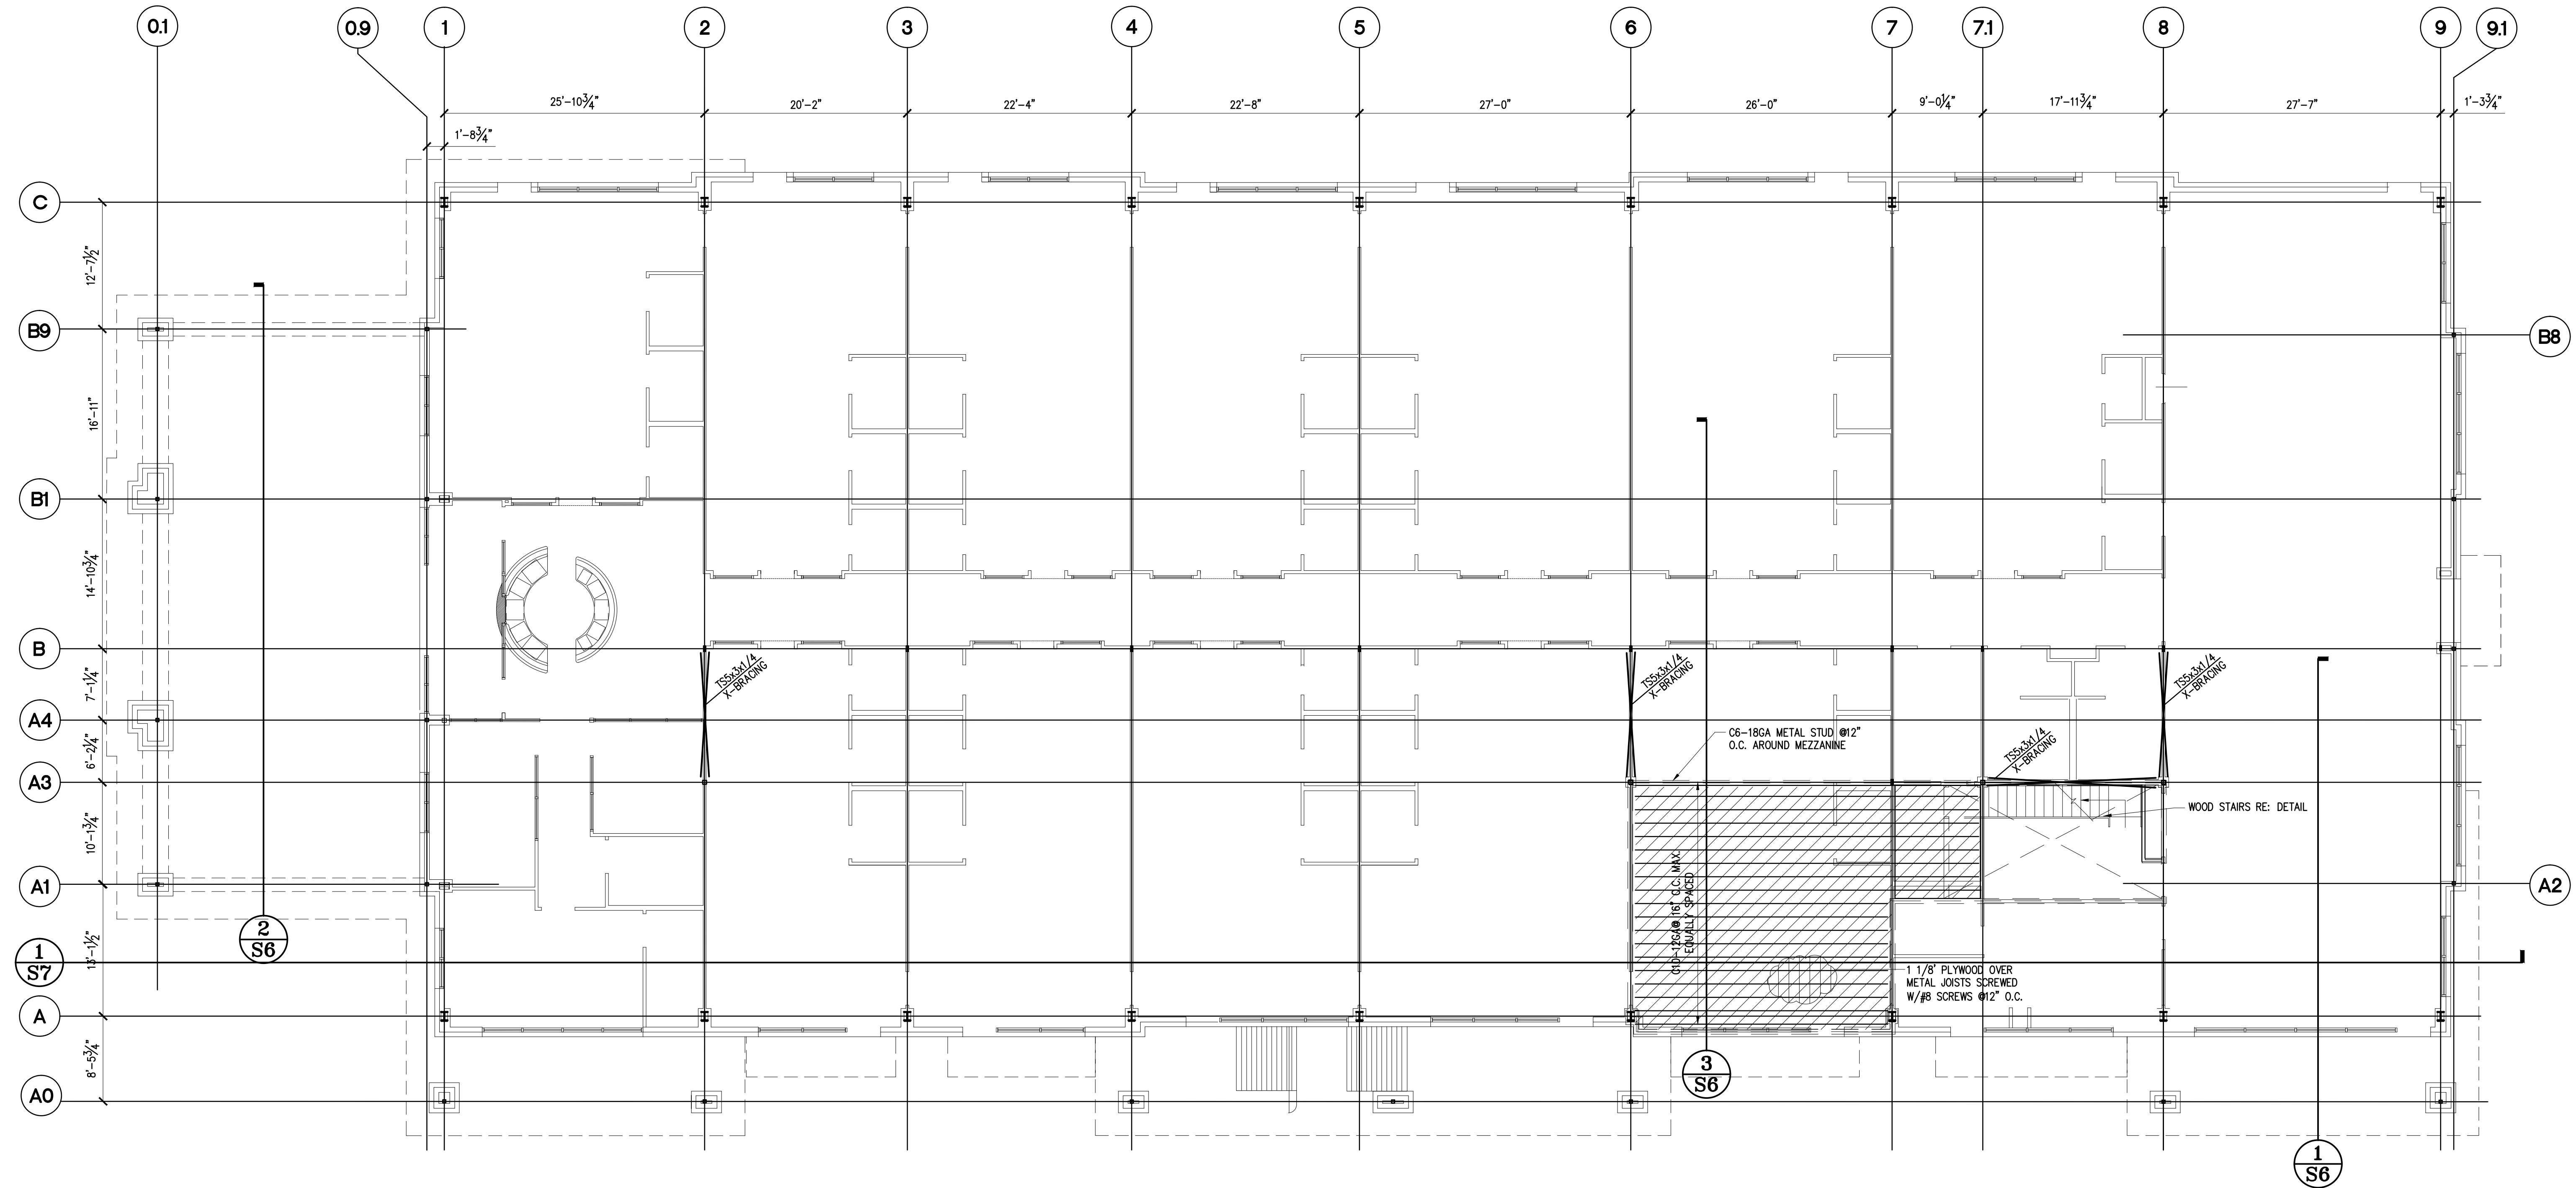

**MEZZANINE FRAMING PLAN**  
SCALE: 1/8" = 1'-0"

- PLAN NOTES:**
- (MC) MOMENT CONNECTION
  - AREA DESIGNATED FOR MEZZANINE ALLOWABLE LIVE LOAD IS 100 PSF.
  - PROVIDE BRIDGING FOR JOISTS AS PER SJI REQUIREMENTS.
  - ALL COLUMNS ARE AS NOTED ON SHEET S1
  - ALL STEEL SHALL BE 50 KSI MATERIAL
  - PROVIDE 2.5" DEEP SEAT FOR ALL BAR JOISTS
  - MIN. JOIST BEARING ON BEAM OR CMU SHALL BE 2.5"
  - PROVIDE CAMBER TO BAR JOISTS AS PER SJI STANDARDS

**LEGEND**  
----- : L2 1/2"x2 1/2"x1/4" X-BRACE

**PE** BUILDINGS  
BRIDGES  
INSPECTIONS  
MARINE STRUCTURES  
CIVIL ENGINEERING &  
STRUCTURAL ENGINEERING

**PARAMOUNT ENGINEERING LLC**

10145 LONG POINT DR.  
HOUSTON, TX 77043  
TEL : (713) 636-9977  
FAX : (281) 888-9128  
CEL : (713) 204-1742

TBPE REGISTRATION # F-3394

CONTRACTOR TO VERIFY ALL DIMENSIONS, ELEVATIONS, AND COORDINATE DETAILS WITH ARCHITECTURAL DRAWINGS. ALL DIMENSIONS & ELEVATION ON ARCHITECTURAL DRAWINGS SHALL GOVERN. IT IS CONTRACTOR'S RESPONSIBILITY TO REPORT TO ENGINEER ABOUT DISCREPANCY IN DRAWINGS PRIOR TO FABRICATION & BIDDING.

DRAWN BY: AS      CHECKED BY: MM

PROJ. NO.: PE19-105

Project No.	1801.74
Date	
Drawn by	
Checked by	
Sheet No.	